



NOTES:

1. Dimensions may vary to fit field conditions.
2. Install a minimum of 3 gravel bag barriers upstream of each drainage inlet to be protected.
3. Position erosion control blanket or geotextile fabric at edge of concrete apron and secure in trench.
4. Erosion control blanket/geotextile fabric is not required if the area adjacent to the drainage inlet is vegetated or paved.

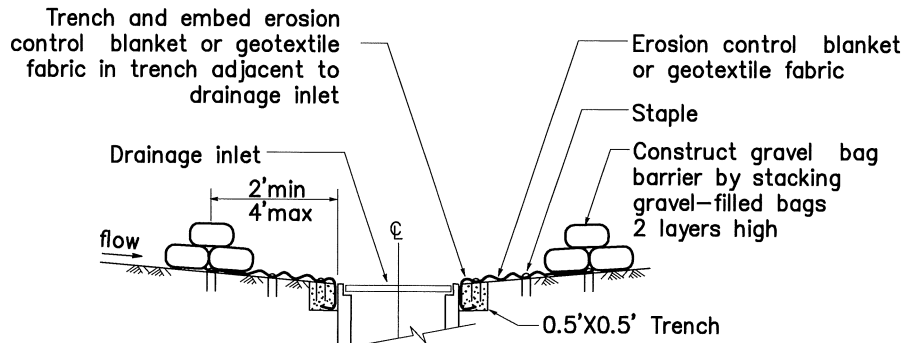


SECTION A-A

NO SCALE

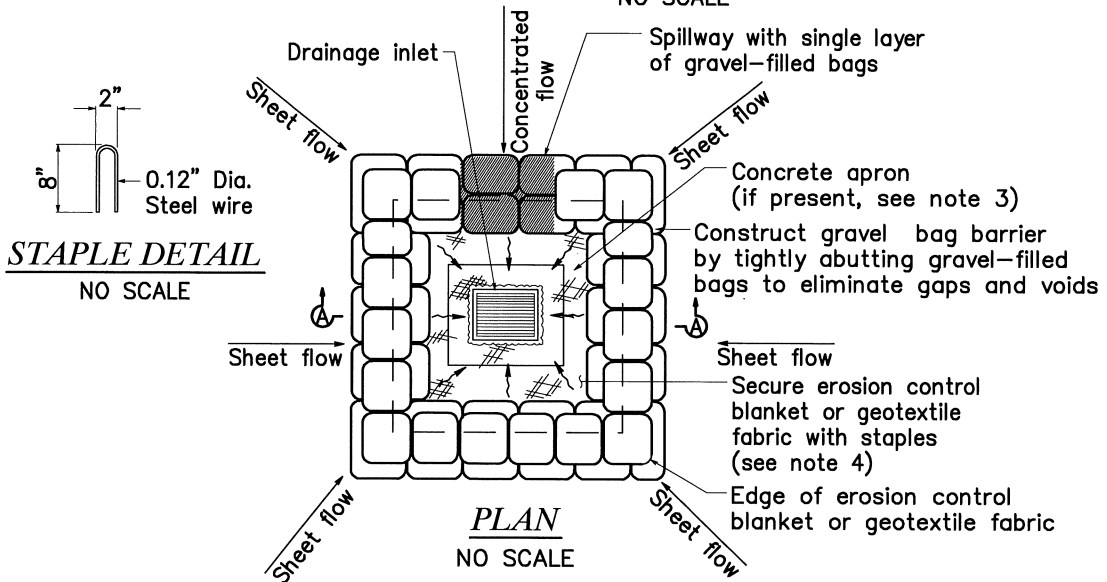

PLAN

NO SCALE

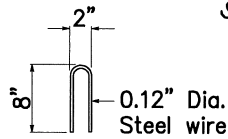

STAPLE DETAIL

NO SCALE

**STORM DRAIN INLET PROTECTION
AREA INLET INSTALLATION**

CITRUS HEIGHTS WATER DISTRICT

APPROVED BY: *Robert A. Churchill*

DATE: 5/8/13

CITRUS HEIGHTS WATER DISTRICT

DRAWN: 8 MAY 2013
 REVISED: NONE
 SCALE: N.T.S.
 DESIGN: P.A.D.
 CAD FILE: SWPPP_103.DWG

PAGE: **SWPPP_103**



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HEIGHTS
WATER
DISTRICT**